




Schedule E Specifications and Standard Drawings


Engineering Division, Updated January 2019

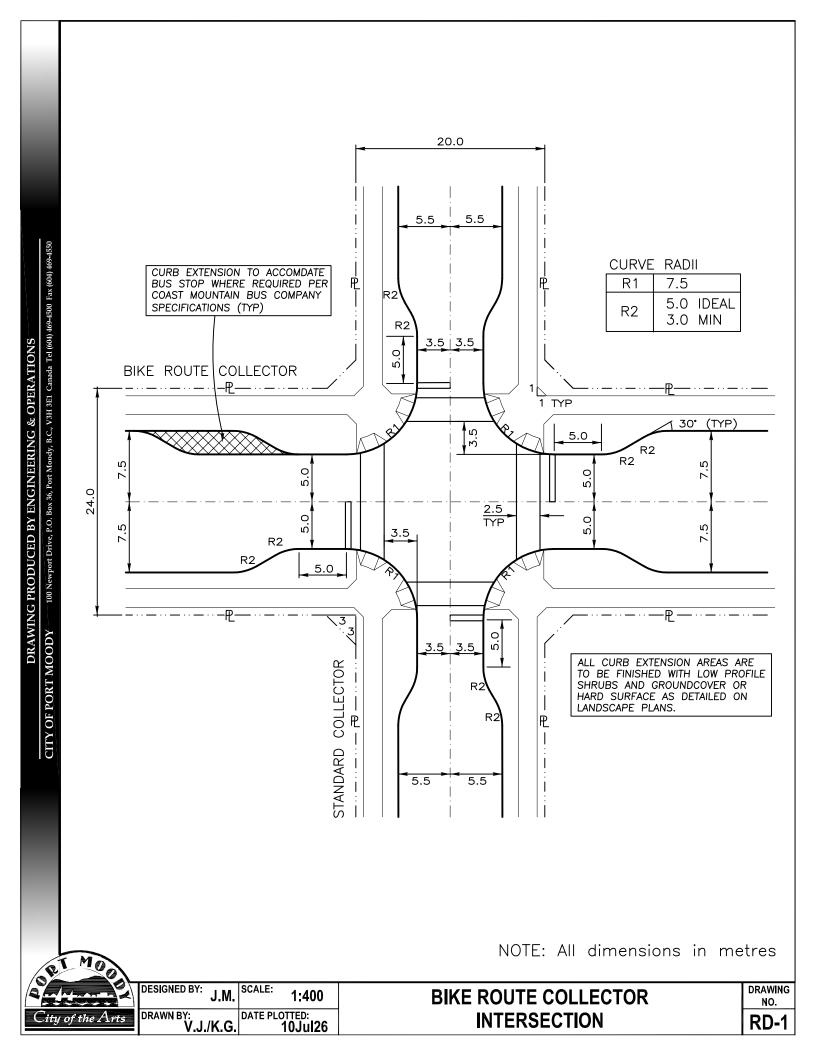

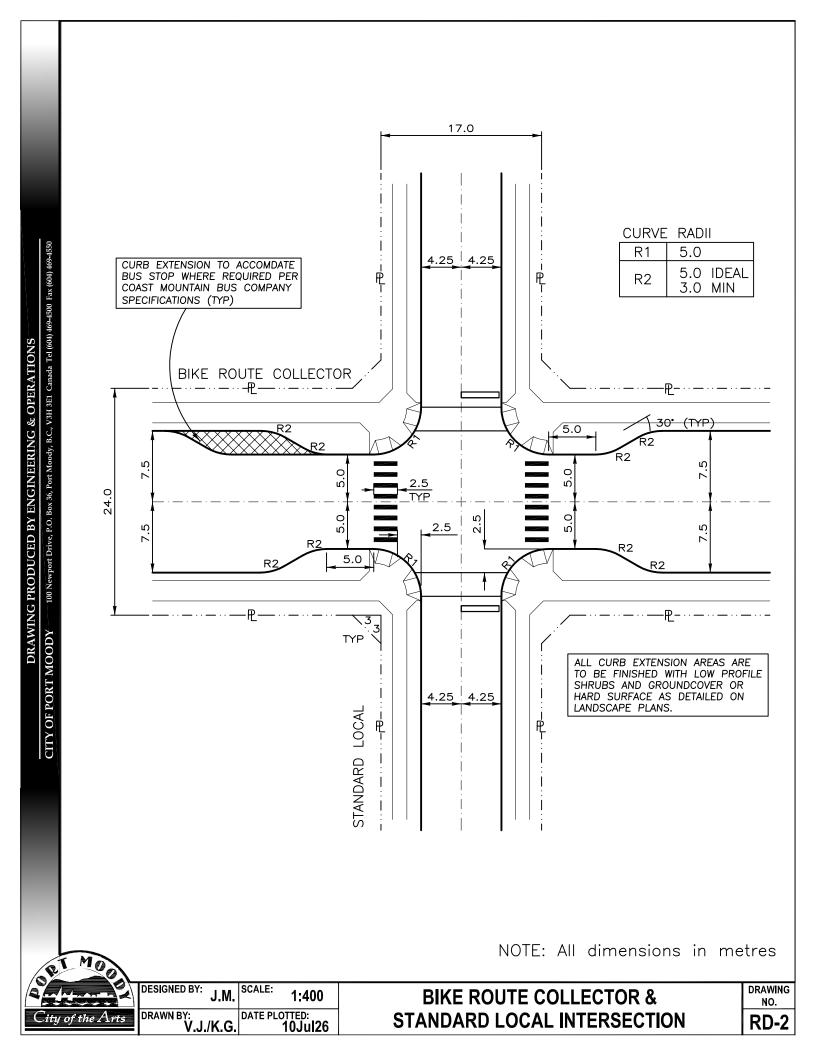

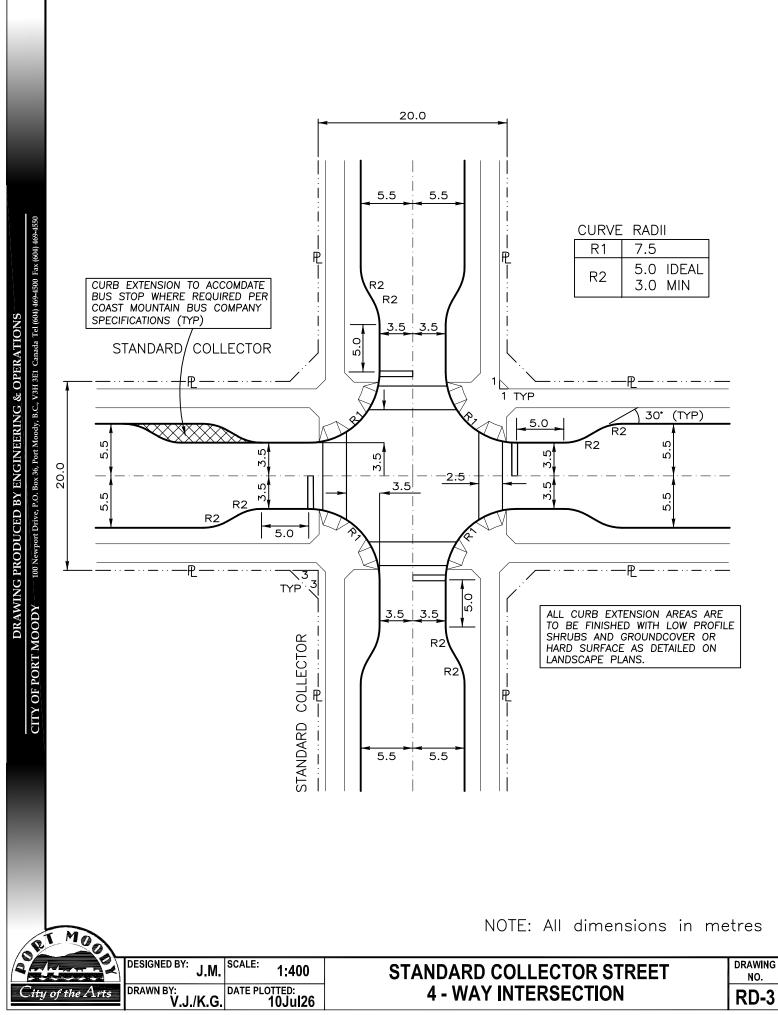

4 - WAY INTERSECTION

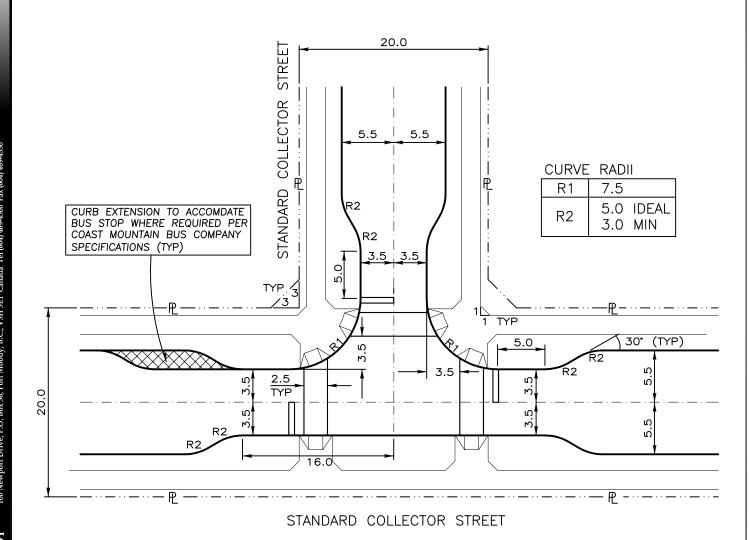

ALL CURB EXTENSION AREAS ARE TO BE FINISHED WITH LOW PROFILE SHRUBS AND GROUNDCOVER OR HARD SURFACE AS DETAILED ON LANDSCAPE PLANS.

NOTE: All dimensions in metres

City of the Arts

DESIGNED BY: J.M. SCALE: 1:400
DRAWN BY: DATE PLOTTED: 10Jul26

STANDARD COLLECTOR STREET 3 - WAY INTERSECTION

DRAWING NO.

CURVE RADIUS

R1 5.0 IDEAL 3.0 MIN

ALL CURB EXTENSION AREAS ARE TO BE FINISHED WITH LOW PROFILE SHRUBS AND GROUNDCOVER OR HARD SURFACE AS DETAILED ON LANDSCAPE PLANS.


NOTE: All dimensions in metres

City of the Arts

DESIGNED BY: J.M. SCALE: 1:400
DRAWN BY: DATE PLOTTED: 10Jul26

STANDARD COLLECTOR STREET MID-BLOCK CROSSWALK

DRAWING NO.

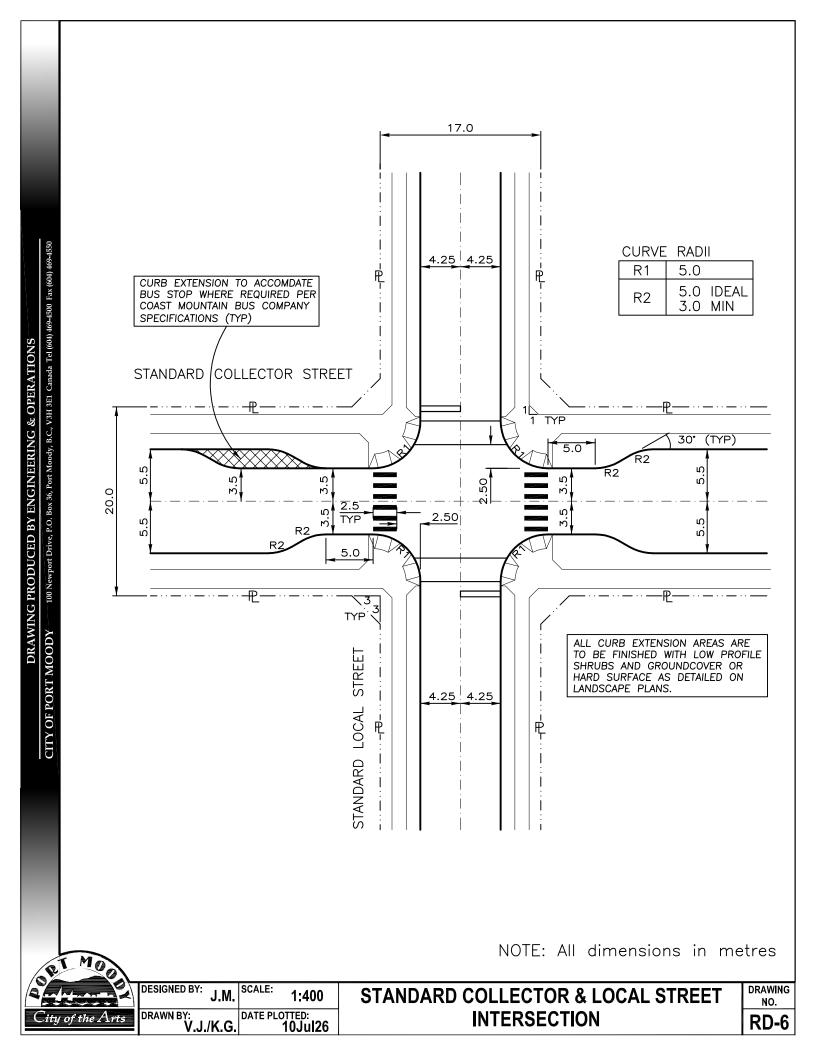


SCALE: DESIGNED BY: 1:400 DRAWN BY: V.J./K.G. DATE PLOTTED: 10Jul26

STANDARD LOCAL STREET INTERSECTION

DRAWING NO.

ity of the Arts

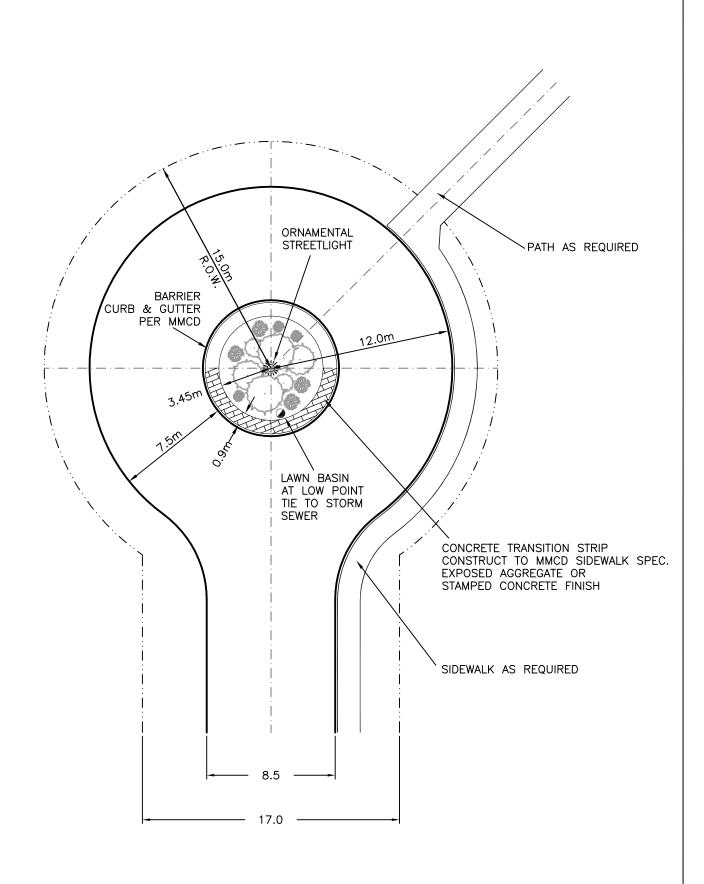


NOTE: All dimensions in metres

DESIGNED BY: A.M. SCALE: 1:250
DRAWN BY: DATE PLOTTED: 10Jul26

RESIDENTIAL CUL-DE-SAC

DRAWING NO.

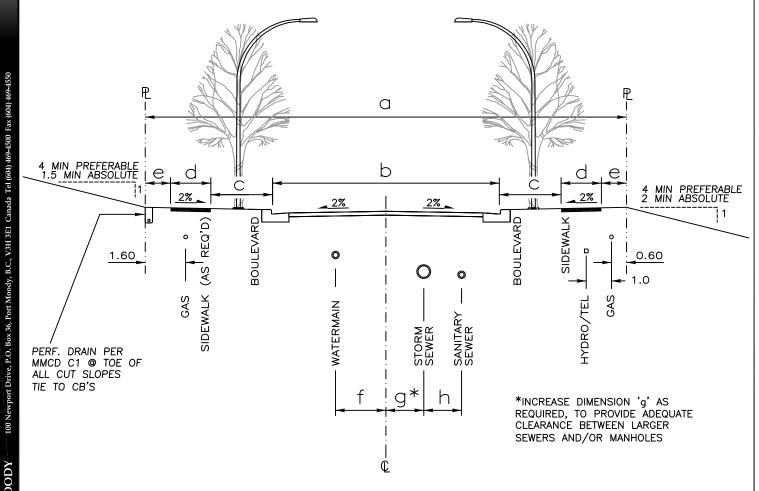

ROAD, SIDEWALK AND BOULEVARD DIMENSIONS									
Street Section	а	b	С	d	е	f	g	h	Additional Information
Arterial	As Required By City								
Bike Route Collector	24.0	15.0	1.7	2.0	0.80	2.0	1.0	1.0	Includes 1.5m Bike Lane
Bike Route Collector (Urban)	24.0	15.0	0.85	2.15	1.50	2.0	1.0	1.0	See RD-12
Standard Collector	20.0	11.0	1.7	2.0	0.80	2.0	1.0	1.0	
Standard Collector (Urban)	20.0	11.0	0.85	2.15	1.5	2.0	1.0	1.0	See RD-12
Standard Local	17.0	8.5	1.5	1.5	1.25	5.5	0	1.0	1 S/W Opp. W/M Pref.
Standard Local (Urban)	17.0	8.5	1.5	1.9	0.85	5.5	0	1.0	See RD-13


NOTE:

City of the Arts

- -All dimensions in metres
- -Watermain to be on 'cut' side

of R/W when possible

,		•	
DESIGNED BY:	J.M.	SCALE:	NTS
DRAWN BY:	/K G	DATE PLO	TTED: 10.Jul26

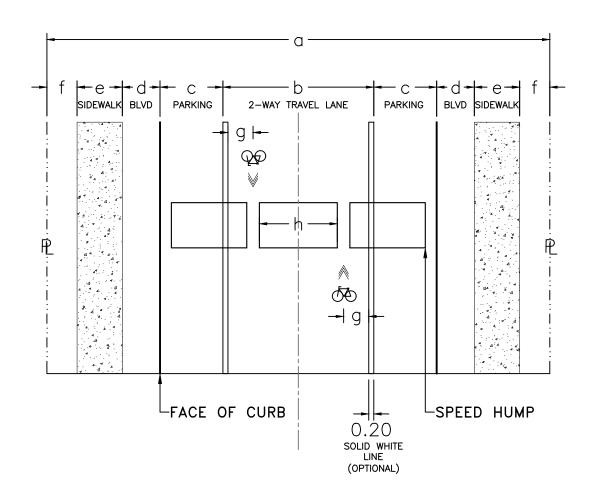

ROAD, SIDEWALK AND BOULEVARD DIMENSIONS									
Street Section	а	b	С	d	е	f	g	h	Additional Information
St George Street	20.0	6.0	2.5	1.5	1.8	1.2	1.0	min 3.0	

NOTE:

- -All dimensions in metres
- -Refer to Sinusoidal Speed Hump Design for 30 KPH
- -Side slopes of speed hump should be no greater than 1:6
- -0.5 meter gap between speed humps
- -Gap to align with sharrow pavement marking
- -Speed humps to be marked with shark teeth
- -Standard Signage from TAC to be installed where required




DESIGNED BY: SCALE: NTS

N.M/S.J. DATE PLOTTED: 1-Mar-2019

NEIGHBOURHOOD BIKEWAY DESIGN TYPICAL ROAD CROSS-SECTION DRAWING NO.

RD-9a

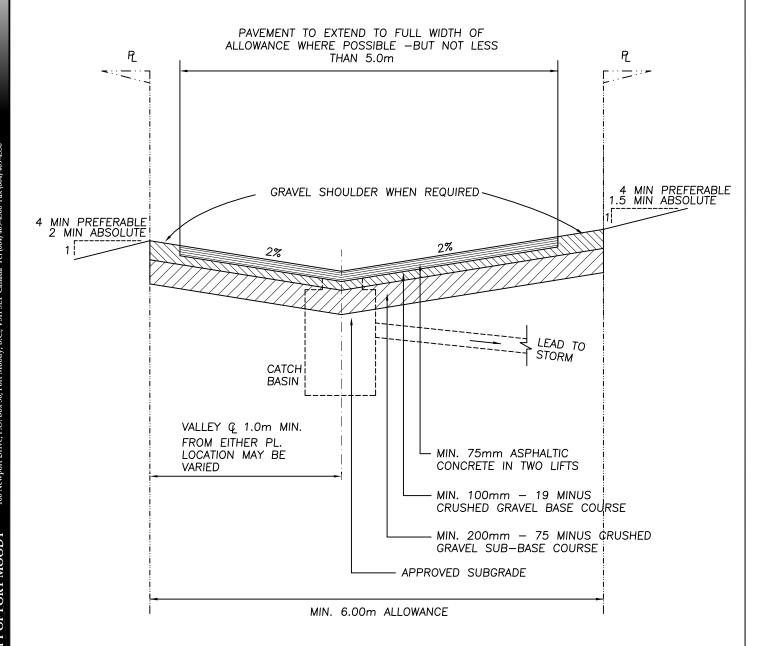

NOTE:
CATCH BASINS TO BE LOCATED AT LOW
POINTS AND CONNECTED TO STORM
SEWER. PROVIDE MIN. OF ONE CATCH
BASIN PER BLOCK.

CURB & GUTTER ON GRAVEL BASE AS PER MMCD MAY BE USED BY DESIGNER WHERE SPECIAL DRAINAGE AND/OR GRADE PROBLEMS REQUIRE.

ALGEBRAIC DIFFERENCE IN CROSSFALL GRADE SHALL NOT EXCEED 6%.

PERMEABLE PAVEMENT OR ALTERNATE ROAD SURFACING MAY BE REQUIRED BY THE DIRECTOR WHERE DEEMED APPROPRIATE.

NOTE: All dimensions in metres

DESIGNED BY: J.M. SCALE: NTS


DRAWN BY: DATE PLOTTED: 10Jul26

ity of the Arts

STANDARD LANE CONSTRUCTION FOR USE IN LEVEL GROUND

DRAWING NO.



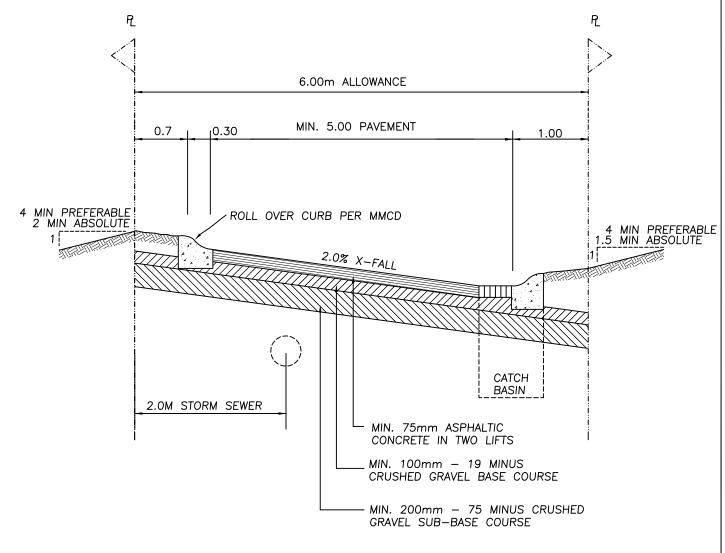

NOTE:

CATCH BASINS TO BE LOCATED AT LOW POINTS AND CONNECTED TO STORM SEWER AS LONGITUDINAL PROFILE REQUIRES AT LEAST ONE PER BLOCK AT LOW END AT CROSS STREET PL.

PERMEABLE PAVEMENT OR ALTERNATE ROAD SURFACING MAY BE REQUIRED BY THE DIRECTOR WHERE DEEMED APPROPRIATE.

NOTE: All dimensions in metres



DESIGNED BY: SCALE J.M. NTS DRAWN BY: V.J./K.G. DATE PLOTTED: 10Jul26

STANDARD LANE CONSTRUCTION-FOR USE IN SLOPING GROUND

DRAWING NO.

NOTE: All dimensions

URBAN NEIGHBOURHOOD DESIGN STANDARDS*						
	Moody Centre - Queens Street to Moody Street	Moody Centre - Moody Street to loco Road	Town Centre			
Paver Bands	Autumn Blend w/ Charcoal Release Agent & Clear Sealant Pewter					
Tree Grates	Dobney Foundry Ivy Series Dobney Foundry SCT Series					

^{*} Equivalent materials will be accepted subject to City review & approval.


DESIGNED BY: A.M. SCALE: 1:100
DRAWN BY: DATE PLOTTED: 10Jul26

lity of the Arts

MOODY / TOWN CENTRE URBAN COLLECTOR ROAD SIDEWALK DETAIL

PL

DRAWING NO.

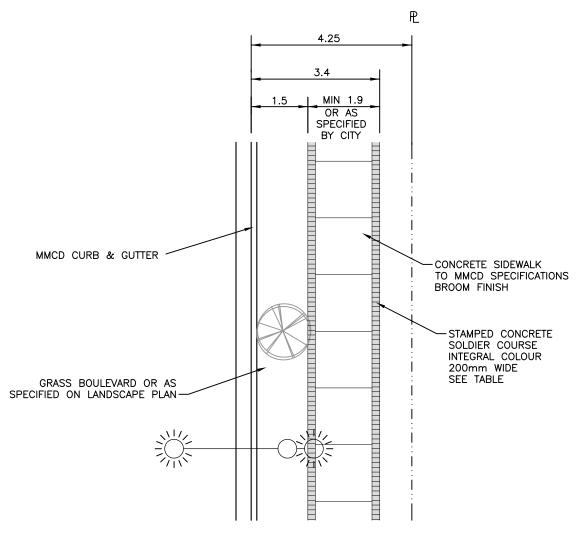

URBAN NEIGHBOURHOOD DESIGN STANDARDS*						
	Moody Centre - Queens Street to Moody Street	Moody Centre - Moody Street to loco Road	Town Centre			
Paver Bands	Autumn Blend w/ Charcoa	l Release Agent & Clear Sealant	Pewter			
Tree Grates	Dobney Foundry Ivy Series Dobney Foundry SCT Series					

* Equivalent materials will be accepted subject to City review & approval.




CITY OF PORT MOODY —— 100 Newport Drive, P.O. Box 36, Port Moody, B.C., V3H 3E1 Canada Tel (604) 469-4500 Fax (604) 469-4550

DESIGNED BY: SCALE: A.M. 1:100 DRAWN BY: V.J./K.G. DATE PLOTTED: 10Jul26

MOODY / TOWN CENTRE URBAN LOCAL ROAD SIDEWALK DETAIL DRAWING NO.

NOTE: All dimensions in metres

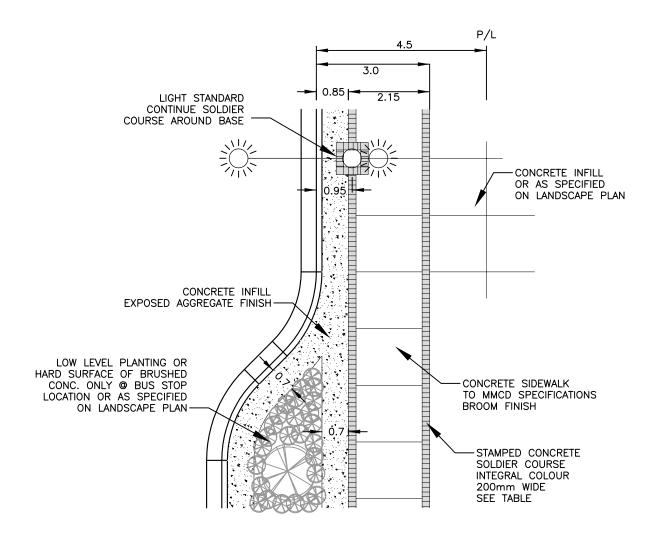

URBAN NEIGHBOURHOOD DESIGN STANDARDS*						
	Moody Centre - Queens Street to Moody Street	Moody Centre - Moody Street to loco Road	Town Centre			
Paver Bands	Autumn Blend w/ Charcoa	l Release Agent & Clear Sealant	Pewter			
Tree Grates	Dobney Foundry Ivy Series Dobney Foundry SCT Series					


^{*} Equivalent materials will be accepted subject to City review & approval.





DESIGNED BY: A.M. SCALE: 1:100
DRAWN BY: DATE PLOTTED: 10Jul26

TYPICAL URBAN
CURB EXTENSION DETAIL

DRAWING NO.

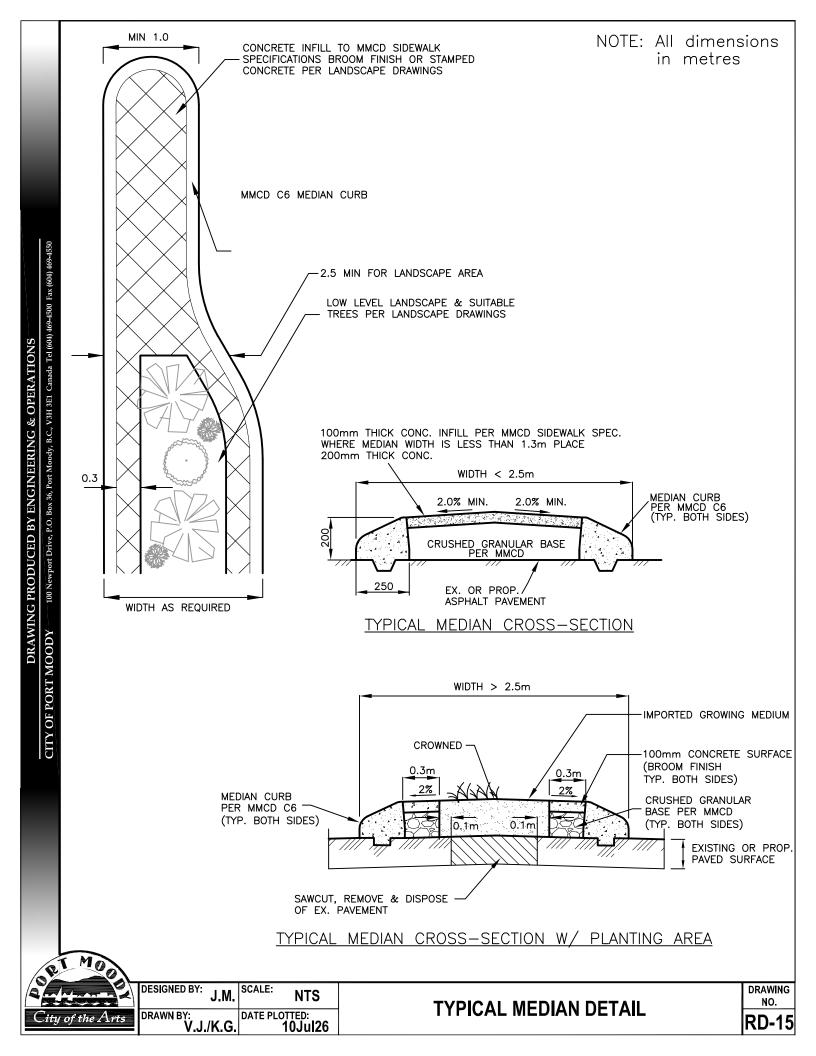

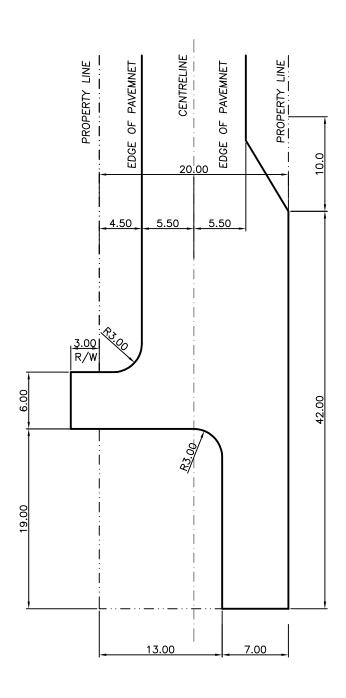

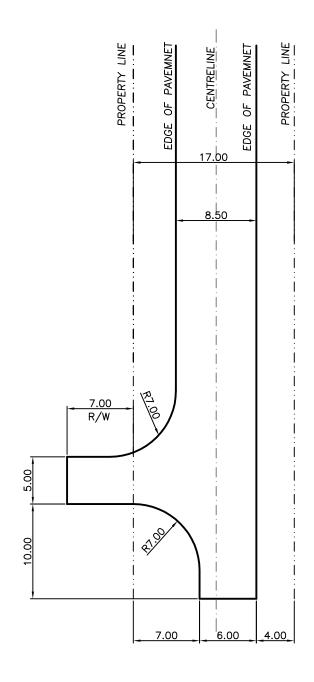


INDUSTRIAL WB-15 DESIGN VEHICLE RESIDENTIAL



DESIGNED BY: SCALE: 1:400 DRAWN BY:
V.J./K.G. DATE PLOTTED: 10Jul26

TYPICAL HAMMERHEAD TURNAROUNDS

DRAWING No.

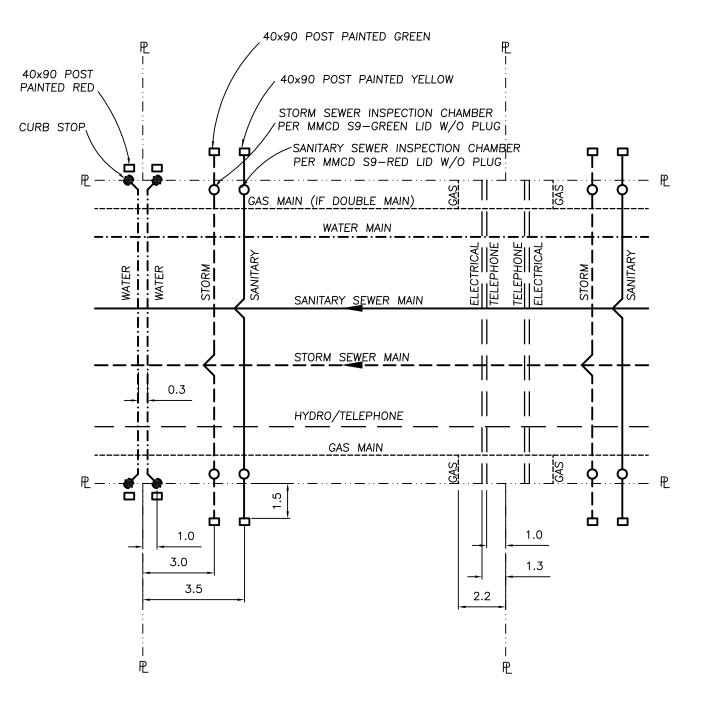

NOTE: - ALL MARKER POSTS TO EXTEND FROM PIPE INVERT TO 0.5 ABOVE GROUND
- CONFIGRATION SHOWN ASSUMES 19-25 MM WATER, 150-200 MM STORM & 100-200 MM SANITARY CONNECTIONS. REFER TO BYLAW 2831 FOR OTHER DIA.




DESIGNED BY: J.M. SCALE: 1:400
DRAWN BY: DATE PLOTTED: 10Jul26

TYPICAL LOT SERVICE CONNECTION LOCATIONS

DRAWING No.

SD-1

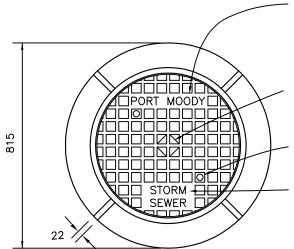


LETTERING SHALL BE 25mm FLAT FACE GOTHIC LETTERING WITH FACE OF LETTERING RAISED TO THE SAME LEVEL AS THE TOP OF RIBS

SYMBOL OF MANUFACTURES Max 90 dia CIRCLE OR SQUARE

25 dia HOLES REQUIRED AS SHOWN

SUBSTITUTE WORDS 'SANITARY SEWER' OR 'WATER' AS REQUIRED

PLAN

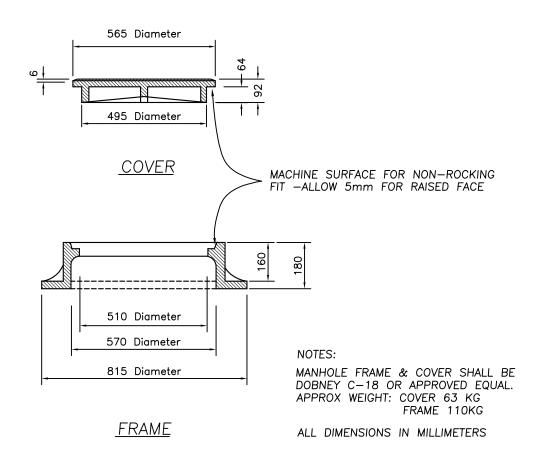





DESIGNED BY: SCALE J.M. 1:15 DRAWN BY: V.J./K.G. DATE PLOTTED: 10Jul26

STANDARD MANHOLE FRAME & COVER

DRAWING NO.

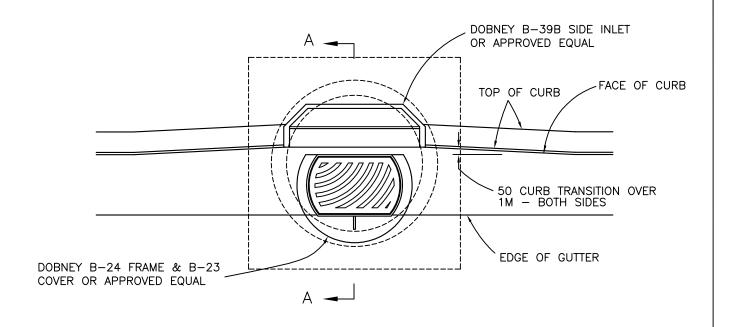

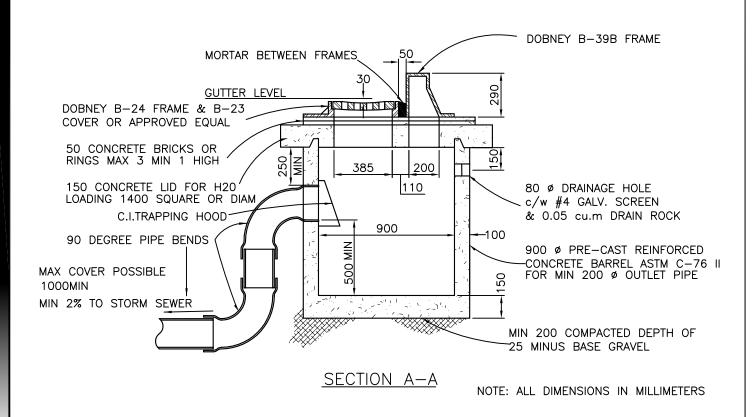




DESIGNED BY: J.M. SCALE: 1:25


DRAWN BY: DATE PLOTTED: 15Sep25

TYPICAL CATCHBASIN FOR USE AT LOW POINTS IN BARRIER CURB

DRAWING NO.


| SD-3

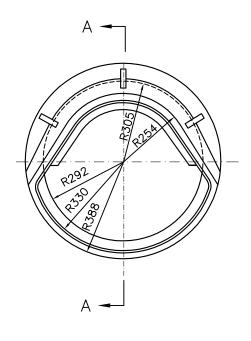

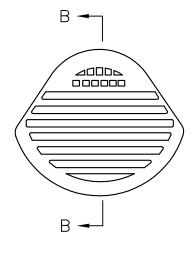

<u>PLAN</u>

<u>PLAN</u>

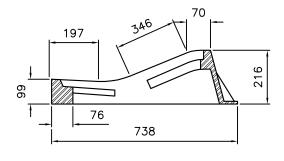

32 203

SECTION B-B

SECTION A-A

COVER

<u>FRAME</u>

NOTES


- 1. FRAME & COVER SHALL BE DOBNEY B-40 OR APPROVED EQUAL 2. CATCHBASIN DETAILS AS SHOWN ON DRAWING SD-3,4,5 EXCEPT BARREL DIAMETER SHALL BE 900mm




DESIGNED BY: SCALE: 1:15 DRAWN BY: V.J./K.G. DATE PLOTTED: 10Jul26

TYPICAL CATCHBASIN FOR USE AT LOW POINTS IN ROLLOVER CURB

DRAWING NO.

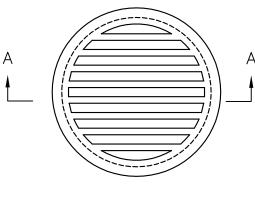

PLAN

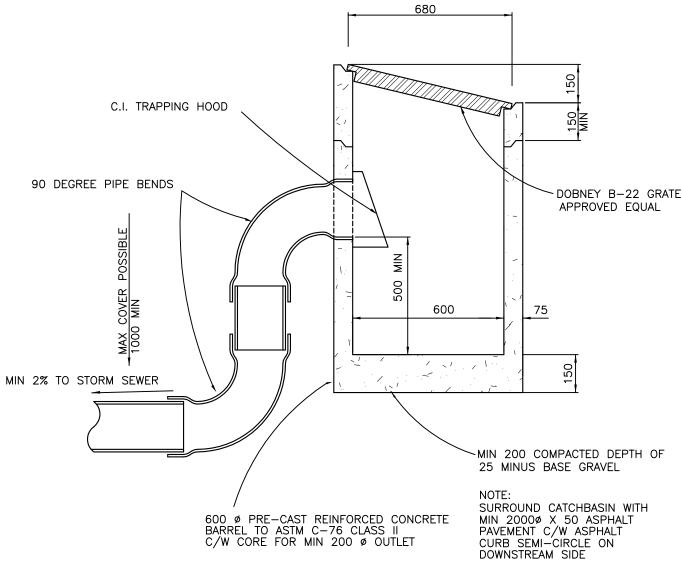

SECTION A-A




DESIGNED BY: SCALE: J.M. 1:15 DRAWN BY: V.J./K.G. DATE PLOTTED: 10Jul26

TYPICAL CATCHBASIN FOR SWALES


DRAWING NO.

SD-5



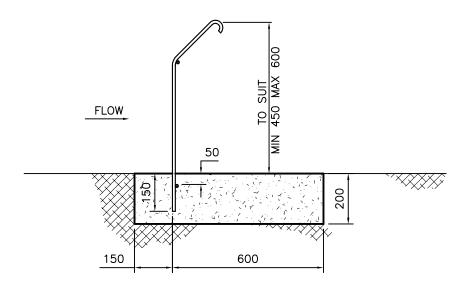

END ELEVATION

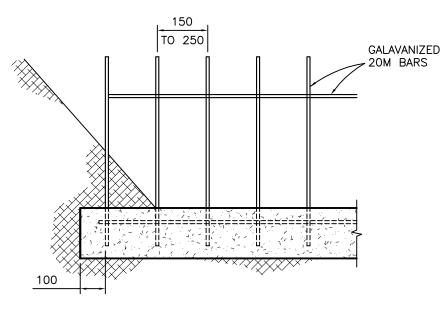

FRONT ELEVATION (PARTIAL)

NOTES:

- CONCRETE SHALL BE MINIMUM 21 MPa AT 28 DAYS
- BARS TO BE WELDED TOGETHER PRIOR TO INSTALLATION
 TRASH SCREEN TO EXTEND ACROSS FULL WIDTH OF DITCH OR WATERCOURSE
- 4. TRASH SCREEN SHALL NOT BE INSTALLED WITHIN 1.0M OF CULVERT OR HEADWALL



DESIGNED BY:	J.M.	SCALE:	1:15
DRAWN BY:	/K.G.	DATE PLO	TTED: 10Jul26

WD-